




SPECIES		QUANTITY	MIN. HEIGHT TO BE PLANTED (cm)	MAINTENANCE	BIODIVERSITY
C Tn	Choisya Ternata 'Mexican Orange Blossom'	1	30	Propagate by semi-hardwood cuttings. Prune out any diseased, damaged or dead shoots and thin out crowded shoots. After pruning, plants benefit from mulching and feeding.	Bees Butterflies
Pi te	Pittosporum tenuifolium 'Sllver Queen' (f/v) tawhiwhi 'Silver queen'	1	40	Propagate by semi-hardwood cuttings in Summer. No routine pruning necessary. Remove diseased, damaged, congested or crossing shoots. After pruning, mulch and feed.	
Fa Ja V.	Fatsia japonica 'Variegata' Japanese aralla 'Variegata'	1	30	Propagate by semi-hardwood cuttings. Prune out any diseased, damaged or dead shoots and thin out crowded shoots. After pruning, plants benefit from mulching and feeding.	
>Ph c	Phormium cookianum subsp. hookeri 'Cream delight' (v)	2	20	Propagate by division in spring. Dead or damaged leaves may be removed in the spring.	Bees Butterflies and other pollinating insects
Euf	Euonymus fortunei 'Emerald Gaiety' (V) spindle 'Emerald Gaiety'	1	20	Propagate by semi-hardwood cuttings. Prune out any diseased, damaged or dead shoots and thin out crowded shoots. After pruning, plants benefit from mulching and feeding.	Bees and other pollinating insects
(H)	Laurel Hedge Prunus Laurocerasus	4	50	Propagate by semi-ripe cuttings from late summer to autumn.Prune out any diseased, damaged or dead shoots and thin out crowded shoots. After pruning, mulch and feed.	Birds and other nesting wildlife
L N.	Lonicera nitida	3	50	Propagate by semi-ripe cuttings from late spring to late summer. Clip any time from spring to autumn.	Birds Insects
Phf	Photinia x fraseri 'Red Robin'	2	50	Propagate by semi-hardwood cuttings in Summer. No routine pruning necessary. Remove diseased, damaged, congested or crossing shoots. After pruning, mulch and feed.	Birds
(:1)	Compact Laurel 'Otto Luyken'	2	50	Propagate by semi-ripe cuttings from late summer to autumn.Prune out any diseased, damaged or dead shoots and thin out crowded shoots. After pruning, mulch and feed.	Birds and other nesting wildlife



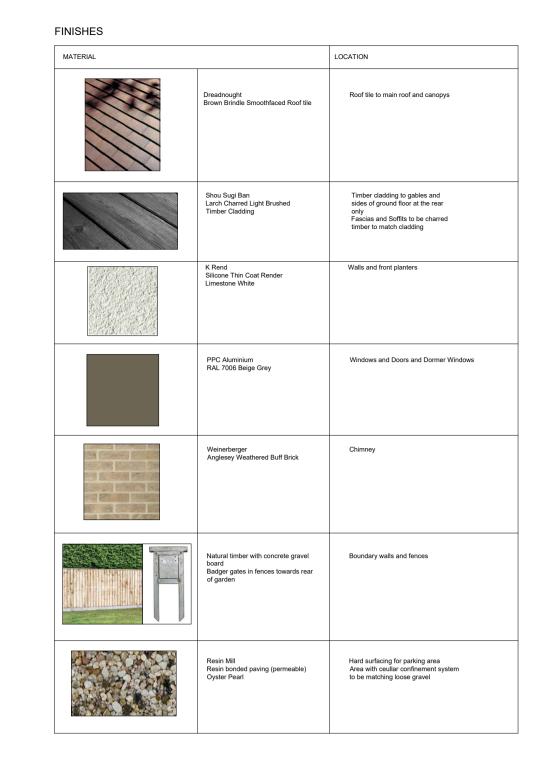

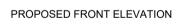


PROPOSED ELEVATIONS - 1:100

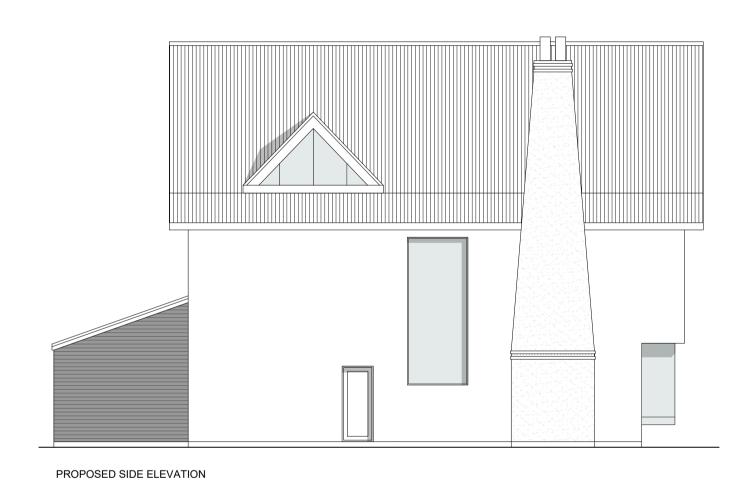







PROPOSED REAR ELEVATION

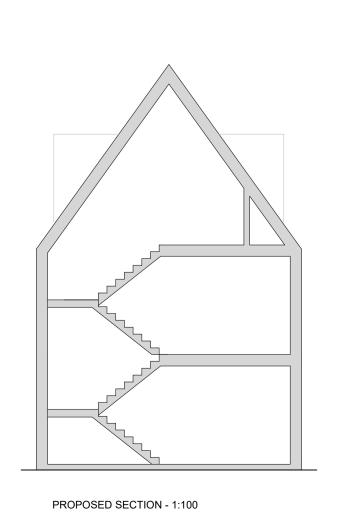

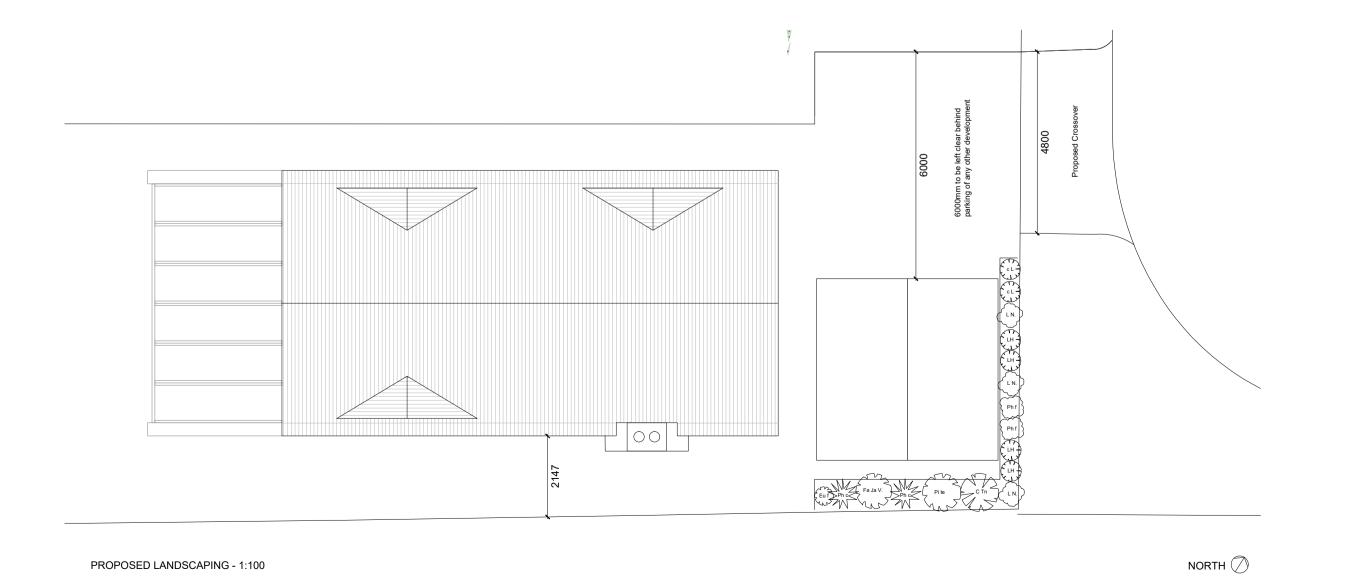

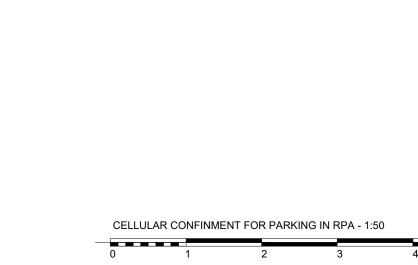

	Note	s:		
,				
	-	-	DS	15/05/2020
	Rev	Comment	Ву	Date
	Stage	: :		
	3 -	Developed Design		
	Clien	t:		
	Mı	G Newton		

Proposed	
Drawing no: 385-P80	Revision:
Project no: 385	Drawn by: DS, MRS

SKARCHITE	CTS	
Scale: 1:50, 1:100 @ A1	Chkd by:	SK
Project no: 385	Drawn by:	DS, MRS

853-855 London Road Westcliff-on-Sea SS0 9SZ
Tel: 01702 509250 Email: info@skarchitects.co.uk

Hayden House 10 Underwood Square Leigh - on - sea

SS9 3PB

Drawing Title:

NB.

Do not scale from this drawing
Drawing to be read in conjunction with all other issued drawings, documents and
relevant consultants' information.
All information on this drawing is for guidance purposes only. All dimensions must
be checked onsite.
This information is subject to Building Control requirements and the requirements
of all relevant statutory authorities and service providers.

© SKArchitects Ltd 2018